



**ABO TENANT IMPROVEMENTS  
LAREDO PLASMAPHERESIS MEDICAL CLINIC**  
1002 GRANT STREET  
LAREDO, TX 78404

**DRAWING INDEX**

SHEET NO.	SHEET NAME	PLUMBING	Mechanical	Electrical	Structural	Architectural	MEP	Structural	Architectural
GS-01	TITLE SHEET	X	X	X	X	X	X	X	X
GS-02	GENERAL NOTES	X	X	X	X	X	X	X	X
LS-001	LIFE SAFETY PLAN - FIRST FLOOR	X	X	X	X	X	X	X	X
LS-002	LIFE SAFETY PLAN - BASEMENT & SECOND FLOOR	X	X	X	X	X	X	X	X
LS-003	ACCESSIBILITY COMPLIANT DETAILS	X	X	X	X	X	X	X	X
C1-01	SITE PLAN	X	X	X	X	X	X	X	X
SG-00	GENERAL NOTES		X	X					
SI-00	EXIST. BASEMENT PLAN		X	X					
SI-01	EXISTING MAIN FLOOR PLAN		X	X					
SI-02	EXIST. SECOND FLOOR PLAN		X	X					
SI-03	EXIST. ROOF FRAMING AND RTU SUPPORT		X	X					
SI-05	EXIST. ROOF FRAMING AND RTU SUPPORT		X	X					
AD-01	WALL TYPES	X	X	X					
AD-02	WALL TYPES	X	X	X					
AD-03	MISCELLANEOUS COLD-FORMED METAL FRAMING DETAILS	X	X	X					
AI-10	NEW FLOOR PLAN - BASEMENT	X	X	X	X	X	X	X	X
AI-11	NEW FLOOR PLAN - FIRST FLOOR	X	X	X	X	X	X	X	X
AI-12	NEW FLOOR PLAN - SECOND FLOOR	X	X	X	X	X	X	X	X
AI-21	NEW ROOF PLAN	X	X	X	X	X	X	X	X
AI-30	REFLECTED CEILING PLAN - BASEMENT	X	X	X	X	X	X	X	X
AI-31	REFLECTED CEILING PLAN - FIRST FLOOR	X	X	X	X	X	X	X	X
AI-32	REFLECTED CEILING PLAN - SECOND FLOOR	X	X	X	X	X	X	X	X
AI-41	FIRST FLOOR PLAN - ENLARGED PLAN	X	X	X	X	X	X	X	X
AI-42	FIRST FLOOR PLAN - ENLARGED PLAN	X	X	X	X	X	X	X	X
AI-43	FIRST FLOOR PLAN - ENLARGED PLAN	X	X	X	X	X	X	X	X
AI-44	FIRST FLOOR PLAN - ENLARGED PLAN	X	X	X	X	X	X	X	X
AI-51	FINISH PLAN - FIRST FLOOR	X	X	X	X	X	X	X	X
AI-71	FF&E PLAN - FIRST FLOOR	X	X	X	X	X	X	X	X
AI-81	SIGNAGE PLAN & DETAILS	X	X	X	X	X	X	X	X
AI-82	SIGNAGE DETAILS	X	X	X	X	X	X	X	X
AE-01	EXTERIOR ELEVATIONS	X	X	X	X	X	X	X	X
AE-01	DOOR & HORIZONTAL SCHEDULE	X	X	X	X	X	X	X	X
AE-02	WINDOWS & DETAILS	X	X	X	X	X	X	X	X
AE-21	ROOM FINISH SCHEDULE & MATERIAL SCHEDULE	X	X	X	X	X	X	X	X
AE-41	ARTWORK PLAN - FIRST FLOOR	X	X	X	X	X	X	X	X
AE-42	ARTWORK ELEVATIONS	X	X	X	X	X	X	X	X
AE-41	BUILDING SECTIONS	X	X	X	X	X	X	X	X
AE-42	STAIR & SHED SECTIONS	X	X	X	X	X	X	X	X
AE-21	DETAILS	X	X	X	X	X	X	X	X
AE-22	DETAILS	X	X	X	X	X	X	X	X
AE-23	DETAILS	X	X	X	X	X	X	X	X
AE-24	STAIR DETAILS	X	X	X	X	X	X	X	X
AE-01	INTERIOR ELEVATIONS	X	X	X	X	X	X	X	X
AE-02	INTERIOR ELEVATIONS	X	X	X	X	X	X	X	X
AE-03	INTERIOR ELEVATIONS	X	X	X	X	X	X	X	X
AE-01	CASEWORK SECTIONS	X	X	X	X	X	X	X	X
AE-02	CASEWORK SECTIONS	X	X	X	X	X	X	X	X

SHEET NO.	SHEET NAME	PLUMBING	Mechanical	Electrical	Structural	Architectural	MEP	Structural	Architectural
P0-01	PLUMBING COVER SHEET	X	X	X					
P1-01	BASEMENT SANITARY & VENT PLAN	X	X	X					
P1-02	FIRST FLOOR SANITARY & VENT PLAN	X	X	X					
P1-03	SECOND FLOOR SANITARY & VENT PLAN	X	X	X					
P2-01	BASEMENT WATER PLAN	X	X	X					
P2-02	FIRST FLOOR WATER PLAN	X	X	X					
P2-03	PLUMBING ROOF PLAN	X	X	X					
P6-01	PLUMBING SCHEDULES	X	X	X					
P6-01	PLUMBING SCHEDULES	X	X	X					
P7-01	SANITARY & VENT ISOMETRIC	X	X	X					
M0-01	MECHANICAL COVER SHEET	X	X	X					
M0-02	MECHANICAL GENERAL NOTES	X	X	X					
M1-01	1ST FLOOR MECHANICAL PLAN	X	X	X					
M1-02	2ND FLOOR MECHANICAL PLAN	X	X	X					
M1-03	BASEMENT FLOOR MECHANICAL PLAN	X	X	X					
M2-01	MECHANICAL ROOF PLAN	X	X	X					
M6-01	MECHANICAL DETAILS	X	X	X					
M6-01	MECHANICAL SCHEDULES	X	X	X					
M6-02	MECHANICAL SCHEDULES	X	X	X					
M6-03	MECHANICAL COMCHECK	X	X	X					
M6-03	MECHANICAL COMCHECK	X	X	X					
E0-01	ELECTRICAL COVER SHEET	X	X	X					
E1-01	BASEMENT LIGHTING PLAN	X	X	X					
E1-02	FIRST FLOOR LIGHTING PLAN	X	X	X					
E1-03	SECOND FLOOR LIGHTING PLAN	X	X	X					
E2-01	BASEMENT POWER PLAN AREA A	X	X	X					
E2-02	BASEMENT POWER PLAN AREA B	X	X	X					
E2-03	BASEMENT POWER PLAN AREA C	X	X	X					
E2-04	BASEMENT POWER PLAN AREA D	X	X	X					
E2-11	FIRST FLOOR POWER PLAN AREA A	X	X	X					
E2-12	FIRST FLOOR POWER PLAN AREA B	X	X	X					
E2-13	FIRST FLOOR POWER PLAN AREA C	X	X	X					
E2-14	FIRST FLOOR POWER PLAN AREA D	X	X	X					
E2-21	SECOND FLOOR POWER PLAN AREA A	X	X	X					
E2-22	SECOND FLOOR AND MEZZANINE POWER PLANS AREA B	X	X	X					
E2-23	SECOND FLOOR POWER PLAN AREA C	X	X	X					
E2-24	SECOND FLOOR POWER PLAN AREA D	X	X	X					
E2-31	ROOF POWER PLAN	X	X	X					
E3-01	BASEMENT DATA PLAN AREA B	X	X	X					
E3-11	FIRST FLOOR DATA PLAN AREA A	X	X	X					
E3-12	FIRST FLOOR DATA PLAN AREA B	X	X	X					
E3-13	FIRST FLOOR DATA PLAN AREA C	X	X	X					
E3-14	FIRST FLOOR DATA PLAN AREA D	X	X	X					
E3-21	SECOND FLOOR DATA PLAN AREA C	X	X	X					
E5-01	ELECTRICAL DETAILS	X	X	X					
E5-02	ELECTRICAL DETAILS	X	X	X					
E6-01	ELECTRICAL SCHEDULES	X	X	X					
E6-02	ELECTRICAL SCHEDULES	X	X	X					
E7-01	ELECTRICAL RISER DIAGRAM	X	X	X					
E6-01	ENERGY CODE COMPLIANCE	X	X	X					
E6-02	ENERGY CODE COMPLIANCE	X	X	X					

**PROJECT NAME:** ABO PLASMA LAREDO LLC  
**PROJECT NO:** 5456  
**DATE:** 01/12/2023 - PERMIT

**PROPERTY OWNER:** ABO HOLDINGS  
2030 MAIN ST. SUITE 1650  
IRVINE, CA 92614  
513.520.0570

**MEP CONSULTANT:** PE-SERVICES  
9 NORTH BROADWAY ST.  
LEBANON, OH 45036  
513.836.3810

**STRUCTURAL CONSULTANT:** MCNEIL ENGINEERING  
8610 SANDY PARKWAY SUITE 200  
SANDY, UT 84070  
801.255.7700

**PROJECT DESCRIPTION**

PROJECT IS THE INTERIOR RENOVATION OF AN EXISTING THREE-STORY RETAIL/BUSINESS BUILDING TO ESTABLISH A MEDICAL CENTER FOR PLASMAPHERESIS DONATION, PROCESSING AND TRAINING. PATIENTS ARE AMBULATORY AND CAPABLE OF SELF-PRESERVATION. THE AVAILABLE BUILDING SPACE IS 36,460 TOTAL SQ. FT. AREA AND BASED ON HISTORICAL DATA AVAILABLE WAS LAST PLATTED IN 1998. INTERIOR WORK WHICH IS LIMITED MAINLY TO THE 12,570 SQ. FT. GRADE LEVEL WILL INCLUDE NEW PARTITIONS AND FINISHES. IMPROVEMENT OF TOILET FACILITIES, STORAGE AND BLOOD PLASMA, AND ALL REQUIRED ELECTRICAL, POWER, LIGHTING AND HVAC FOR THE INTERIOR ENVIRONMENT. EXTERIOR RENOVATIONS WILL BE LIMITED TO REHABILITATION OF THE EXISTING FACADE. IDENTIFICATION SIGNAGE AND LOCATION OF HVAC UNITS ON THE EXISTING ROOF. STRUCTURAL MODIFICATIONS ARE REMOVAL OF A MEZZANINE LEVEL, IMPROVEMENTS TO EGRESS STAIRS, AND IMPROVED STRUCTURAL SUPPORT OF THE ROOF TOP UNITS PER STAT. DYNAMIC AND SEISMIC DESIGN STANDARDS IN CONFORMANCE WITH THE BUILDING CODE. ALL SAID WORK IS WITHIN THE CURRENT TENANT LEASE SPACE AND DOES NOT INVOLVE THE EXPANSION INTO ADJACENT AREAS OR OUTSIDE OF THE CURRENT BUILDING FOOTPRINT.

**BUILDING DESCRIPTION PER LAREDO TEXAS BUILDING CODE**

EXISTING OCCUPANCY	M - MERCANTILE (GRADE LEVEL, 1 <sup>ST</sup> STORAGE (BASEMENT & 2ND LEVEL)	309.1, 311.2
PROPOSED OCCUPANCY	B - BUSINESS (GRADE LEVEL) UNCHANGED BASEMENT & 2ND LEVEL	304.1
PROPOSED USE	MEDICAL CLINIC	302.1
ALLOWABLE BUILDING AREA	NONSEPARATED MIXED OCCUP., MULTISTORY BUILDING - 15,625 SQ.FT.	T506.2, 506.2.4
ACTUAL TENANT AREA	BASEMENT - 11,320 SQ. FT. FIRST FLOOR - 12,570 SQ. FT. SECOND FLOOR - 10,724 SQ. FT.	508.13 508.32 508.3
ALLOWABLE BUILDING HEIGHT	≤ 55 FT. 2 STORIES ABOVE GRADE	T504.3, T504.4
ACTUAL BUILDING HEIGHT	2 - STORY ABOVE GRADE (NO CHANGE)	
MIXED USE AND OCCUPANCY	NON-SEPARATED OCCUPANCY	508.3
OCCUPANCY CLASSIFICATION	INDIVIDUALLY CLASSIFIED	508.3.1
CONSTRUCTION CLASSIFICATION	B-B	602.2
<b>FIRE RESISTANCE RATINGS</b>		TABLE 601
STRUCTURAL FRAME	0 HR	TABLE 601
EXTERIOR WALLS - LOAD BEARING	0 HR	TABLE 601
INTERIOR WALLS - LOAD BEARING	0 HR	TABLE 601
EXTERIOR WALLS - NON LOAD BEARING	0 HR	TABLE 601
INTERIOR WALLS - NON LOAD BEARING	0 HR	TABLE 601
FLOOR CONSTRUCTION	0 HR	TABLE 601
ROOF CONSTRUCTION	0 HR	TABLE 601
FIRE RESISTANCE RATING FOR EXT. WALLS	2 HR - FIRE SEPARATION DISTANCE IS LESS THAN 5 FT. (EXISTING)	TABLE 602
INTERIOR FINISHES	EXIT ENCLOSURE AND EXIT PASSAGE PASSAGEWAYS: R USE GROUP - CLASS B CORRIDORS: B USE GROUP - CLASS C ROOMS AND ENCLOSED SPACES: B USE GROUP - CLASS C INTERIOR FLOOR FINISHES SHALL COMPLY WITH ASTM STANDARD E666 AND HAVE SMOKE RATING NOT TO EXCEED 450 PER ASTM E666. CLASS II MINIMUM RATING, RADON-TIGHT FLUX.	803.13 804.4.1, 804.4.2
FIRE SPRINKLER SYSTEM	EXISTING BUILDING IS NOT SUPPRESSED	
OCCUPANT LOAD	BASEMENT - (S-1 USE) 11,320/500 = 23 OCCUPANTS (CURRENT) FIRST FLOOR - (B USE) 11,450/150 = 77 + (S-1 USE) 1,120/300 = 4, TOTAL 81 SECOND FLOOR - (S-1 USE) 10,724/500 = 22 OCCUPANTS (CURRENT)	TABLE 1004.5 TABLE 1004.5 TABLE 1004.5
MEANS OF EGRESS SIZING	EGRESS CAPACITY = 0.2'	1005.3.2
REQUIRED EGRESS WIDTH	BASEMENT: 23 x 0.2' = 4.6'; FIRST FLOOR: 81 x 0.2' = 16.2'; SECOND FLOOR: 22 x 0.2' = 4.4'	1005.3.2
REQUIRED EGRESS WIDTH - STAIRWAYS	BASEMENT: 23 x 0.3' = 6.9'; SECOND FLOOR: 22 x 0.3' = 6.6'	1005.3.1
WIDTH PROVIDED	SINGLE W/ID ENTRY/EXIT DOOR: 3'0" / 0.2 = 165 PERSONS DOUBLE W/ID ENTRY/EXIT DOOR: 6'0" / 0.2 = 300 PERSONS	1005.2
REMOVENESS OF EXITS (NONSPRINKLERED)	1/2 MAX OF OVERALL DIAGONAL (160 FT.) J = 80 FT. ACTUAL REMOTE DISTANCE BETWEEN FRONT & REAR EXITS = 145 FT.	1007.1.1
NUMBER OF EXITS (REQUIRED)	2	TABLE 1008.3.2
NUMBER OF EXITS (ACTUAL)	4 AT FIRST FLOOR; 2 EACH AT BASEMENT AND SECOND FLOOR	
COMMON PATH OF TRAVEL	100 FT. (FOR B OR S-1 OCCUPANCY W/O SPRINKLER)	TABLE 1006.2.1
ACCESSIBLE MEANS OF EGRESS	ALL 4 EXITS COMPLY	1009.1
EXIT ACCESS TRAVEL DISTANCE	TRAVEL DISTANCE, W/O SPRINKLER SYSTEM - 200'	TABLE 1017.2
MINIMUM CORRIDOR WIDTH	36" FOR OCC. LOAD OF 49 OR LESS 44" FOR OCC. LOAD GREATER THAN 49	TABLE 1002.4
DEAD END CORRIDOR	20-FOET (WITHOUT SPRINKLER SYSTEM)	1020.4
ACCESSIBILITY	COMPLIES WITH TEXAS ACCESSIBILITY STANDARDS	
ACCESSIBLE ROUTE	SITE APPROVAL POINTS, EMPLOYEE WORK AREAS	
<b>SCHEMATIC CODES</b>		
2018 INTERNATIONAL BUILDING CODE	2018 INTERNATIONAL PROPERTY MAINTENANCE CODE	
2018 INTERNATIONAL MECHANICAL CODE	2018 INTERNATIONAL ENERGY CONSERVATION CODE	
2018 INTERNATIONAL RESIDENTIAL CODE	2018 INTERNATIONAL EXISTING BUILDING CODE	
2012 TEXAS ACCESSIBILITY STANDARDS	2017 NATIONAL ELECTRICAL CODE OF THE NATIONAL FIRE PROTECTION ASSOCIATION	
2018 INTERNATIONAL FIRE CODE	2018 INTERNATIONAL PRIVATE SEWAGE DISPOSAL CODE	
2018 INTERNATIONAL PLUMBING CODE	2018 INTERNATIONAL SWIMMING POOL AND SPA CODE	
2018 INTERNATIONAL FUEL GAS CODE		

**DEFERRED SUBMITTALS**

X	WALK-IN FREEZER
X	COMCHECK ENERGY COMPLIANCE


**STATEMENT OF SPECIAL INSPECTIONS**

X	NOT REQUIRED FOR THIS PROJECT
X	PLEASE SEE INFORMATION AS PROVIDED ON DRAWINGS
X	NOT REQUIRED FOR THIS PROJECT
X	PLEASE SEE ATTACHED SHEETS

**PLUMBING SYSTEMS**

IBC TABLE 2902.1	CLASSIFICATION	DESCRIPTION	WATER CLOSETS	URINALS	LAVATORIES	DRINKING FOUNTAIN	SERVICE SINK / SINK REOD.
BUSINESS	PROFESSIONAL SERVICES, CLINICAL, 30 MALE, 30 FEMALE	1 PER 25 FOR FIRST 50	1 PER 40 FOR FIRST 80	1 PER 40 FOR FIRST 80	1 PER 150	1	1 SINK
STORAGE	STORAGE OF MEDICAL SUPPLY (TRANSIENT EMPLOYEES)						1 SINK
SUMMARY TOTAL REQUIRED FIXTURES	MALE	FEMALE	2"	2"	1		
TOTAL FURNISHED FIXTURES	3 TLT. + 1 UR.	4	4	4	2		

\* REQUIRED NUMBER BASED ON SEPARATE FIXTURES FOR DONOR AND STAFF  
\*\* 8 HANDWASH LAVATORY PROVIDED FOR STAFF. NOT INCLUDED IN ABOVE FIXTURE COUNT

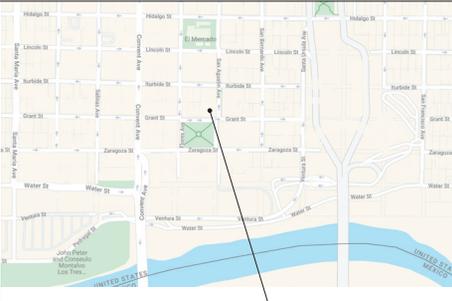

**ACCESSIBILITY**

THE GENERAL CONTRACTOR SHALL COMPLY WITH FEDERAL, STATE AND LOCAL ACCESSIBILITY PROVISIONS, INCLUDING BUT NOT LIMITED TO THE FOLLOWING FEATURES AND FACILITIES:

THE WORK AREA:

1. PATH OF TRAVEL FROM A PUBLIC WAY & ACCESSIBLE PARKING SPACES PRIMARY ENTRANCE AND EXITS FOR PUBLIC AND STAFF.
2. ACCESSIBLE ROUTES & PATHS OF TRAVEL TO ACCESSIBLE SPACES.
3. SANITARY FACILITIES, DRINKING FOUNTAINS, BREAK ROOM FEATURES, MANEUVERABILITY AND CLEAR FLOOR SPACE REQUIREMENTS AT ACCESSIBLE COMPONENTS (DOORS, TOILET FACILITIES, ETC.).

**INTERIOR ENVIRONMENT**


ACTIVE VENTILATION AND TEMPERATURE CONTROL SYSTEM SHALL BE PROVIDED DURING CONSTRUCTION OPERATIONS AND SHALL FUNCTION CONTINUOUSLY DURING APPLICATION OF FINISHES THROUGH OWNER OCCUPANCY.

ARTIFICIAL LIGHTING SYSTEM SHALL BE PROVIDED. EMERGENCY EGRESS LIGHTING SHALL MAINTAIN







**CRAG A. PICKREL**  
REGISTRATION No. 30221  
EXPIRES: 03/31/2025

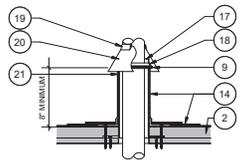

NOTE: PIPE PENETRATION BY PLUMBING CONTRACTOR.  
FLASHING & COUNTER-FLASHING BY ROOFING CONTRACTOR.  
NOTE: DETAIL APPLIES TO HOT FLUE PENETRATIONS.

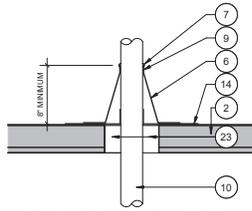


NOTE: PIPE PENETRATION BY PLUMBING CONTRACTOR.  
FLASHING & COUNTER-FLASHING BY ROOFING CONTRACTOR.

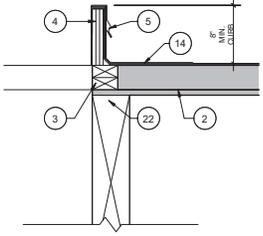

**2 ROOF CURB DETAIL**  
SCALE: 1 1/2" = 1'-0"

**4 PIPE PENETRATION HOT STACK DETAIL**  
SCALE: 1 1/2" = 1'-0"

**3 PIPE PENETRATION DETAIL**  
SCALE: 1 1/2" = 1'-0"

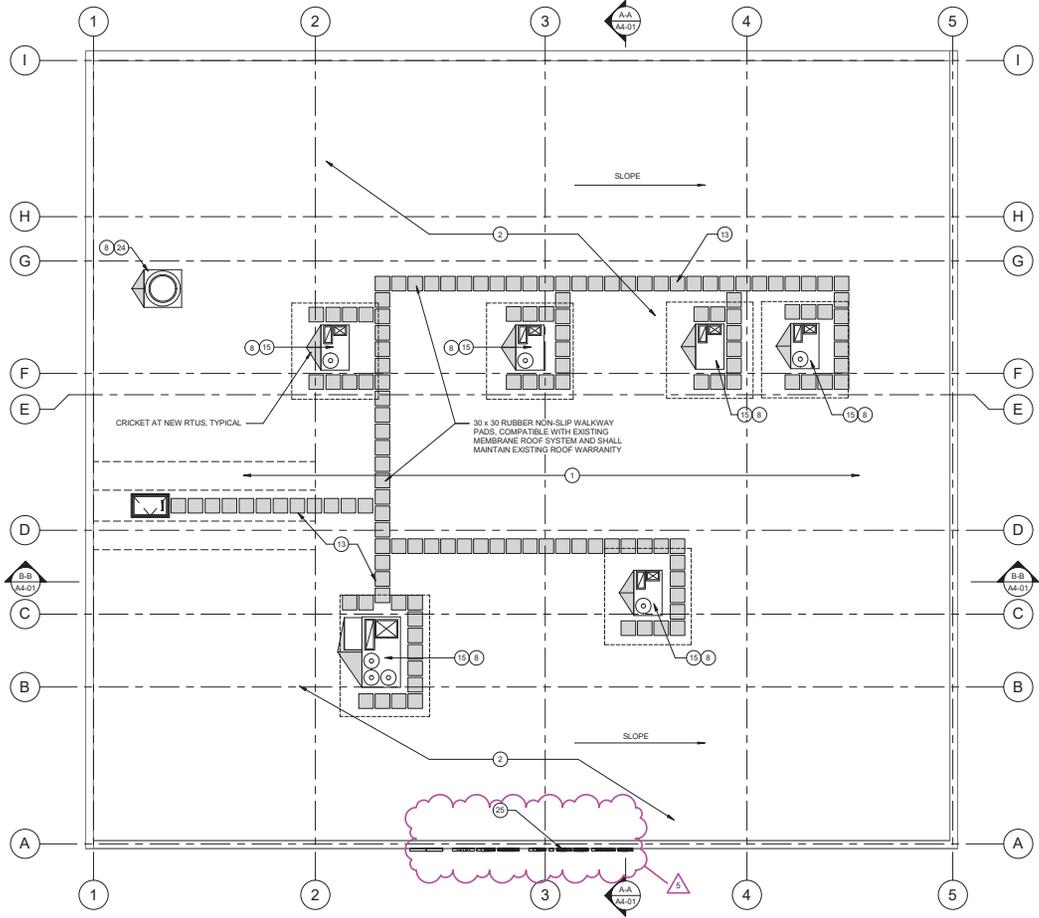

**ROOF**  
SCALE: 1/8" = 1'-0"

**DRAWING NOTES**

- A. EXISTING ROOF SYSTEM - BUILT UP ASPHALT ROOF. ALL ROOFING WORK SHALL COMPLY WITH BUILDING OWNER'S REQUIREMENTS AND MAINTAIN ANY EXISTING ROOF WARRANTY.
- B. ROOFING CONTRACTOR SHALL FINISH AND SEAL CURBS AND OTHER ROOF PENETRATIONS BY OTHER TRADES.
- C. NEW ROOF CURBS SHALL BE INSULATED.

**KEY NOTES**

- 1. EXHAUST FAN - SEE MECHANICAL DRAWINGS.
- 2. EXISTING ROOF CONSTRUCTION. SEE DRAWING NOTE "A".
- 3. WOOD BLOCKING AS REQUIRED TO LEVEL CURB.
- 4. ROOF CURB. COORDINATE WITH MECHANICAL CONTRACTOR.
- 5. FLASHING AND COUNTER FLASHING.
- 6. FLEXIBLE NEOPRENE OR RUBBER PIPE BOOT FLASHING. SEALED TOP AND BOTTOM.
- 7. CONTINUOUS SEALANT (WATER CUT-OFF MASTIC) SUITED FOR APPLICATION AS RECOMMENDED BY MFG.
- 8. ROOF CURB. COORD WITH MECHANICAL CONTRACTOR.
- 9. STAINLESS STEEL CLAMPING RING.
- 10. PLUMBING VENT. SEE PLUMBING DRAWINGS.
- 11. ROOFTOP FREEZER EQUIPMENT, OWNER FURNISHED AND INSTALLED. GENERAL CONTRACTOR TO PROVIDE MATERIAL AND INSTALLATION FOR ALL STRUCTURAL SUPPORT OF THE ROOFTOP FREEZER EQUIP.
- 12. ACCESS LADDER TO REMAIN AT EXISTING LOCATION.
- 13. WALKWAY PADS.
- 14. SINGLE-PLY MEMBRANE FLASHING.
- 15. NEW ROOFTOP UNIT. ROOF PENETRATION AND SUPPORT CURB BY ROOFING CONTRACTOR. COORDINATE WITH MECHANICAL CONTRACTOR. SEE MECHANICAL DRAWINGS.
- 16. NEW ROOFTOP FREEZER CONDENSING UNITS, OWNER FURNISHED AND INSTALLED. GENERAL CONTRACTOR TO PROVIDE MATERIAL AND INSTALLATION FOR ALL STRUCTURAL SUPPORT OF THE ROOFTOP FREEZER EQUIPMENT.
- 17. INSULATED METAL SLEEVE BY GENERAL CONTRACTOR.
- 18. CONTINUOUS BEAD OF SEALANT.
- 19. CONTINUOUS BEAD OF TEMPERATURE OR HIGH GRADE SEALANT.
- 20. FIELD FABRICATED METAL HOOD.
- 21. ACCEPTABLE BONDING ADHESIVE.
- 22. NEW GULLIAM BEAM. REFER TO STRUCTURAL FOR LOCATION, FASTENING & EXTENTS
- 23. CLOSED CELL SPRAY-FOAM TO SEAL GAPS BETWEEN PENETRATION STRUCTURE AND EXISTING ROOF SICK INSULATION.
- 24. NEW ROOFTOP UPBLAST EXHAUST FAN. ROOF PENETRATION AND SUPPORT CURB BY ROOFING CONTRACTOR. COORDINATE WITH MECHANICAL CONTRACTOR. SEE MECHANICAL DRAWINGS.
- 25. SIGNAGE LOCATION. SEE A2-01

REVISION	DESCRIPTION	DATE	BY
5	SIGNAGE PERMIT	07/11/2025	CAP
3	BULLETIN 3	05/14/2024	CAP
1	BULLETIN 1	11/08/2023	CAP
	BID CONS. SET	06/23/2023	
	PERMIT RESUB.	03/09/2023	
	PERMIT	01/12/2023	

DRAWN BY: CAP  
CHECKED BY: CAP  
PROJECT NO.: 5346  
START DATE: 09/29/2022

DRAWING TITLE:  
**NEW ROOF PLAN**

DRAWING NO.:  
**A1-21**

